# LARGE SCALE DEVELOPMENT ROGERS SEVENTH DAY ADVENTIST

# 301 N 33RD STREET ROGERS, ARKANSAS

#### Survey Description

A parcel of land situated in the Southeast Quarter (SE1/4) of the Northwest Quarter (NW) of Section 10, Township 19 North, Range 30 West of the Fifth Principle Meridian as set forth in Warranty Deed Book 697, Page 762 and Lot 20 of Sundance Trace Subdivision in Plat Book 11 Page 39 of Benton County Records, Bentonville, Arkansas. Said parcel being more particularly

COMMENCING at the Southeast (SE) corner of the Southeast Quarter (SE1/4) of the Northwest

Thence coincident with the Southern line of the Southeast Quarter (SE1/4) of the Northwest as set forth in Plat Book "G", Page 186 of Benton County Records, Bentonville, Arkansas, North 02°42'21" East for a distance of 615.55 feet to the TRUE POINT OF BEGINNING of the hereinafter described tract:

Thence leaving said Western line, North 84°30'37" West for a distance of 571.24 feet to a point on the Eastern property line for Lot 20 of Sundance Trace Subdivision as set forth in Plat Book 11, Page 39 of Benton County Records, Bentonville, Arkansas;

Thence coincident with said Eastern line, North 01°41'43" East for a distance of 375.09 feet to

Thence leaving said Eastern line, South 87°11'46" East for a distance of 577.09 feet to a point on the Western property line of the Valley West Subdivision as set forth in Plat Book "G", Page 186 of Benton County Records, Bentonville, Arkansas; Thence coincident with said Western line, South 02°41'30" West for a distance of 401.79 feet to the POINT OF BEGINNING and containing 222,833 square feet or 5.12 acres, more or less.

Subject to any and all existing easements, covenants, restrictions or rights—of—way, whether of record or prescription.

# OWNER/DEVELOPER CONTACTS

ARKANSAS CONF ASSOC OF SEVENTH DAY ADVENTIST PO BOX 31000 SHREVEPORT, LA 71130 CONTACT: JEFF QUAM (479)631-5354

### ROGERS CITY/UTILITY CONTACTS

ROGERS PLANNING DEPT. LORI STONE 479 621-1186

lstone@rogersark.gov

ROGERS CITY ENGINEER LANCE JOBE, P.E. 479 621-1186 ljobe@rogersark.gov

ROGERS FIRE DEPT. WILLIAM RUMSEY brumsey@rogersark.gov


ROGERS STREET DEPT. FRANKY GUYLL 479 621-1140 fguyll@rogersark.gov

ROGERS WATER UTILITY STEPHEN PONDER 479 621-1156 stephenponder@rwu.org

ANTHONY WILLIAMS 479 442-3173 aw9156@att.com

COX COMMUNICATIONS LARRY ALEXANDER Cell 479-871-7606 4901 S. 48th St. Springdale, AR 72764


SOURCE GAS KENNETH PETERS Cell (479) 877-0430 1301 Federal Way Lowell, 72745

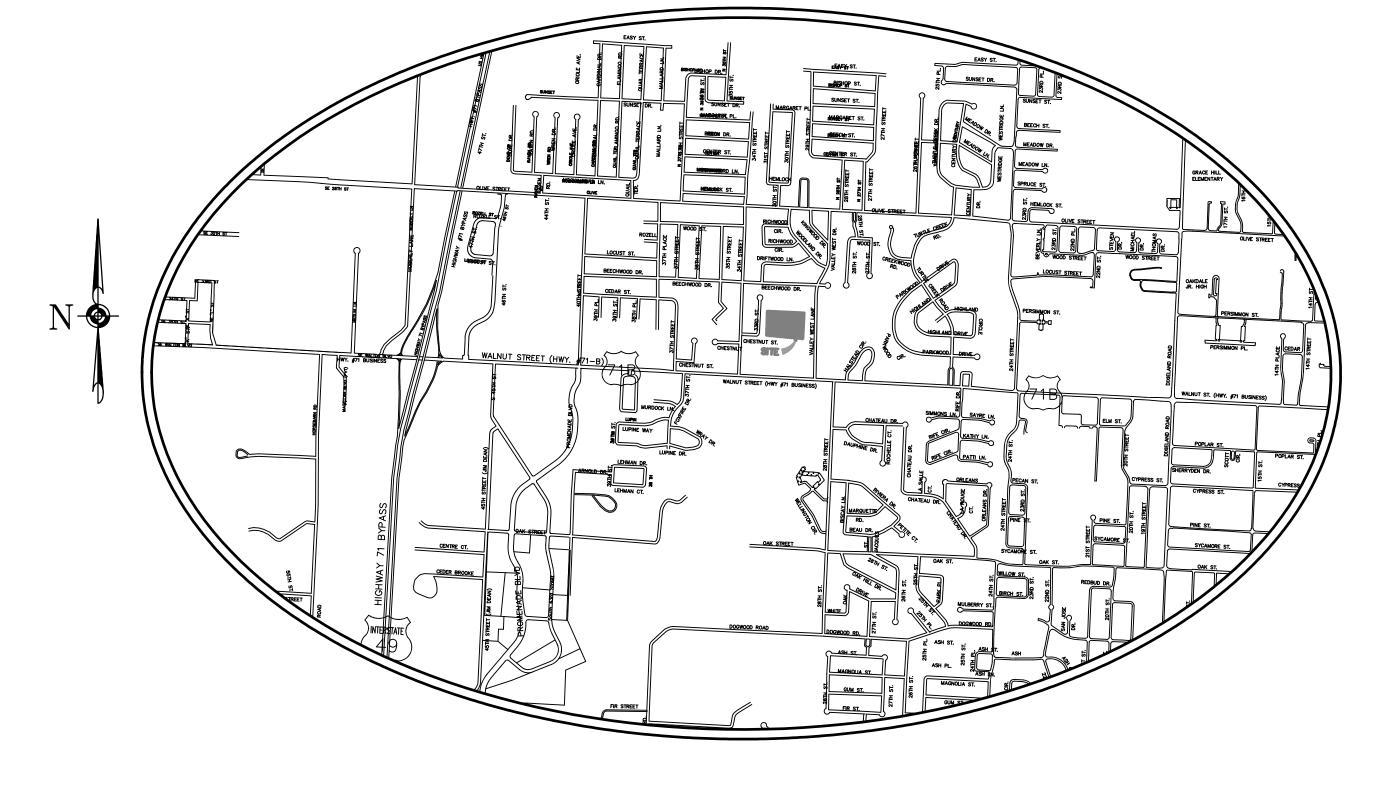



Sheet List Table	
Sheet Number	Sheet Title
1	COVER SHEET
2	SURVEY
3	SITE, UTILITY & LANDSCAPE PLAN
4	GRADING & EROSION CONTROL PLAN
5	DETAIL SHEET
6	ROGERS WATER DETAILS-1
7	ROGERS WATER DETAILS-2
8	ROGERS SEWER DETAILS

VICINITY MAP NTS



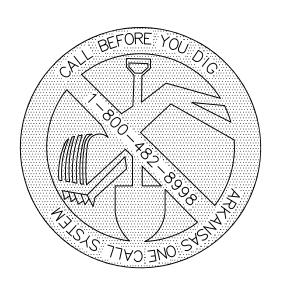

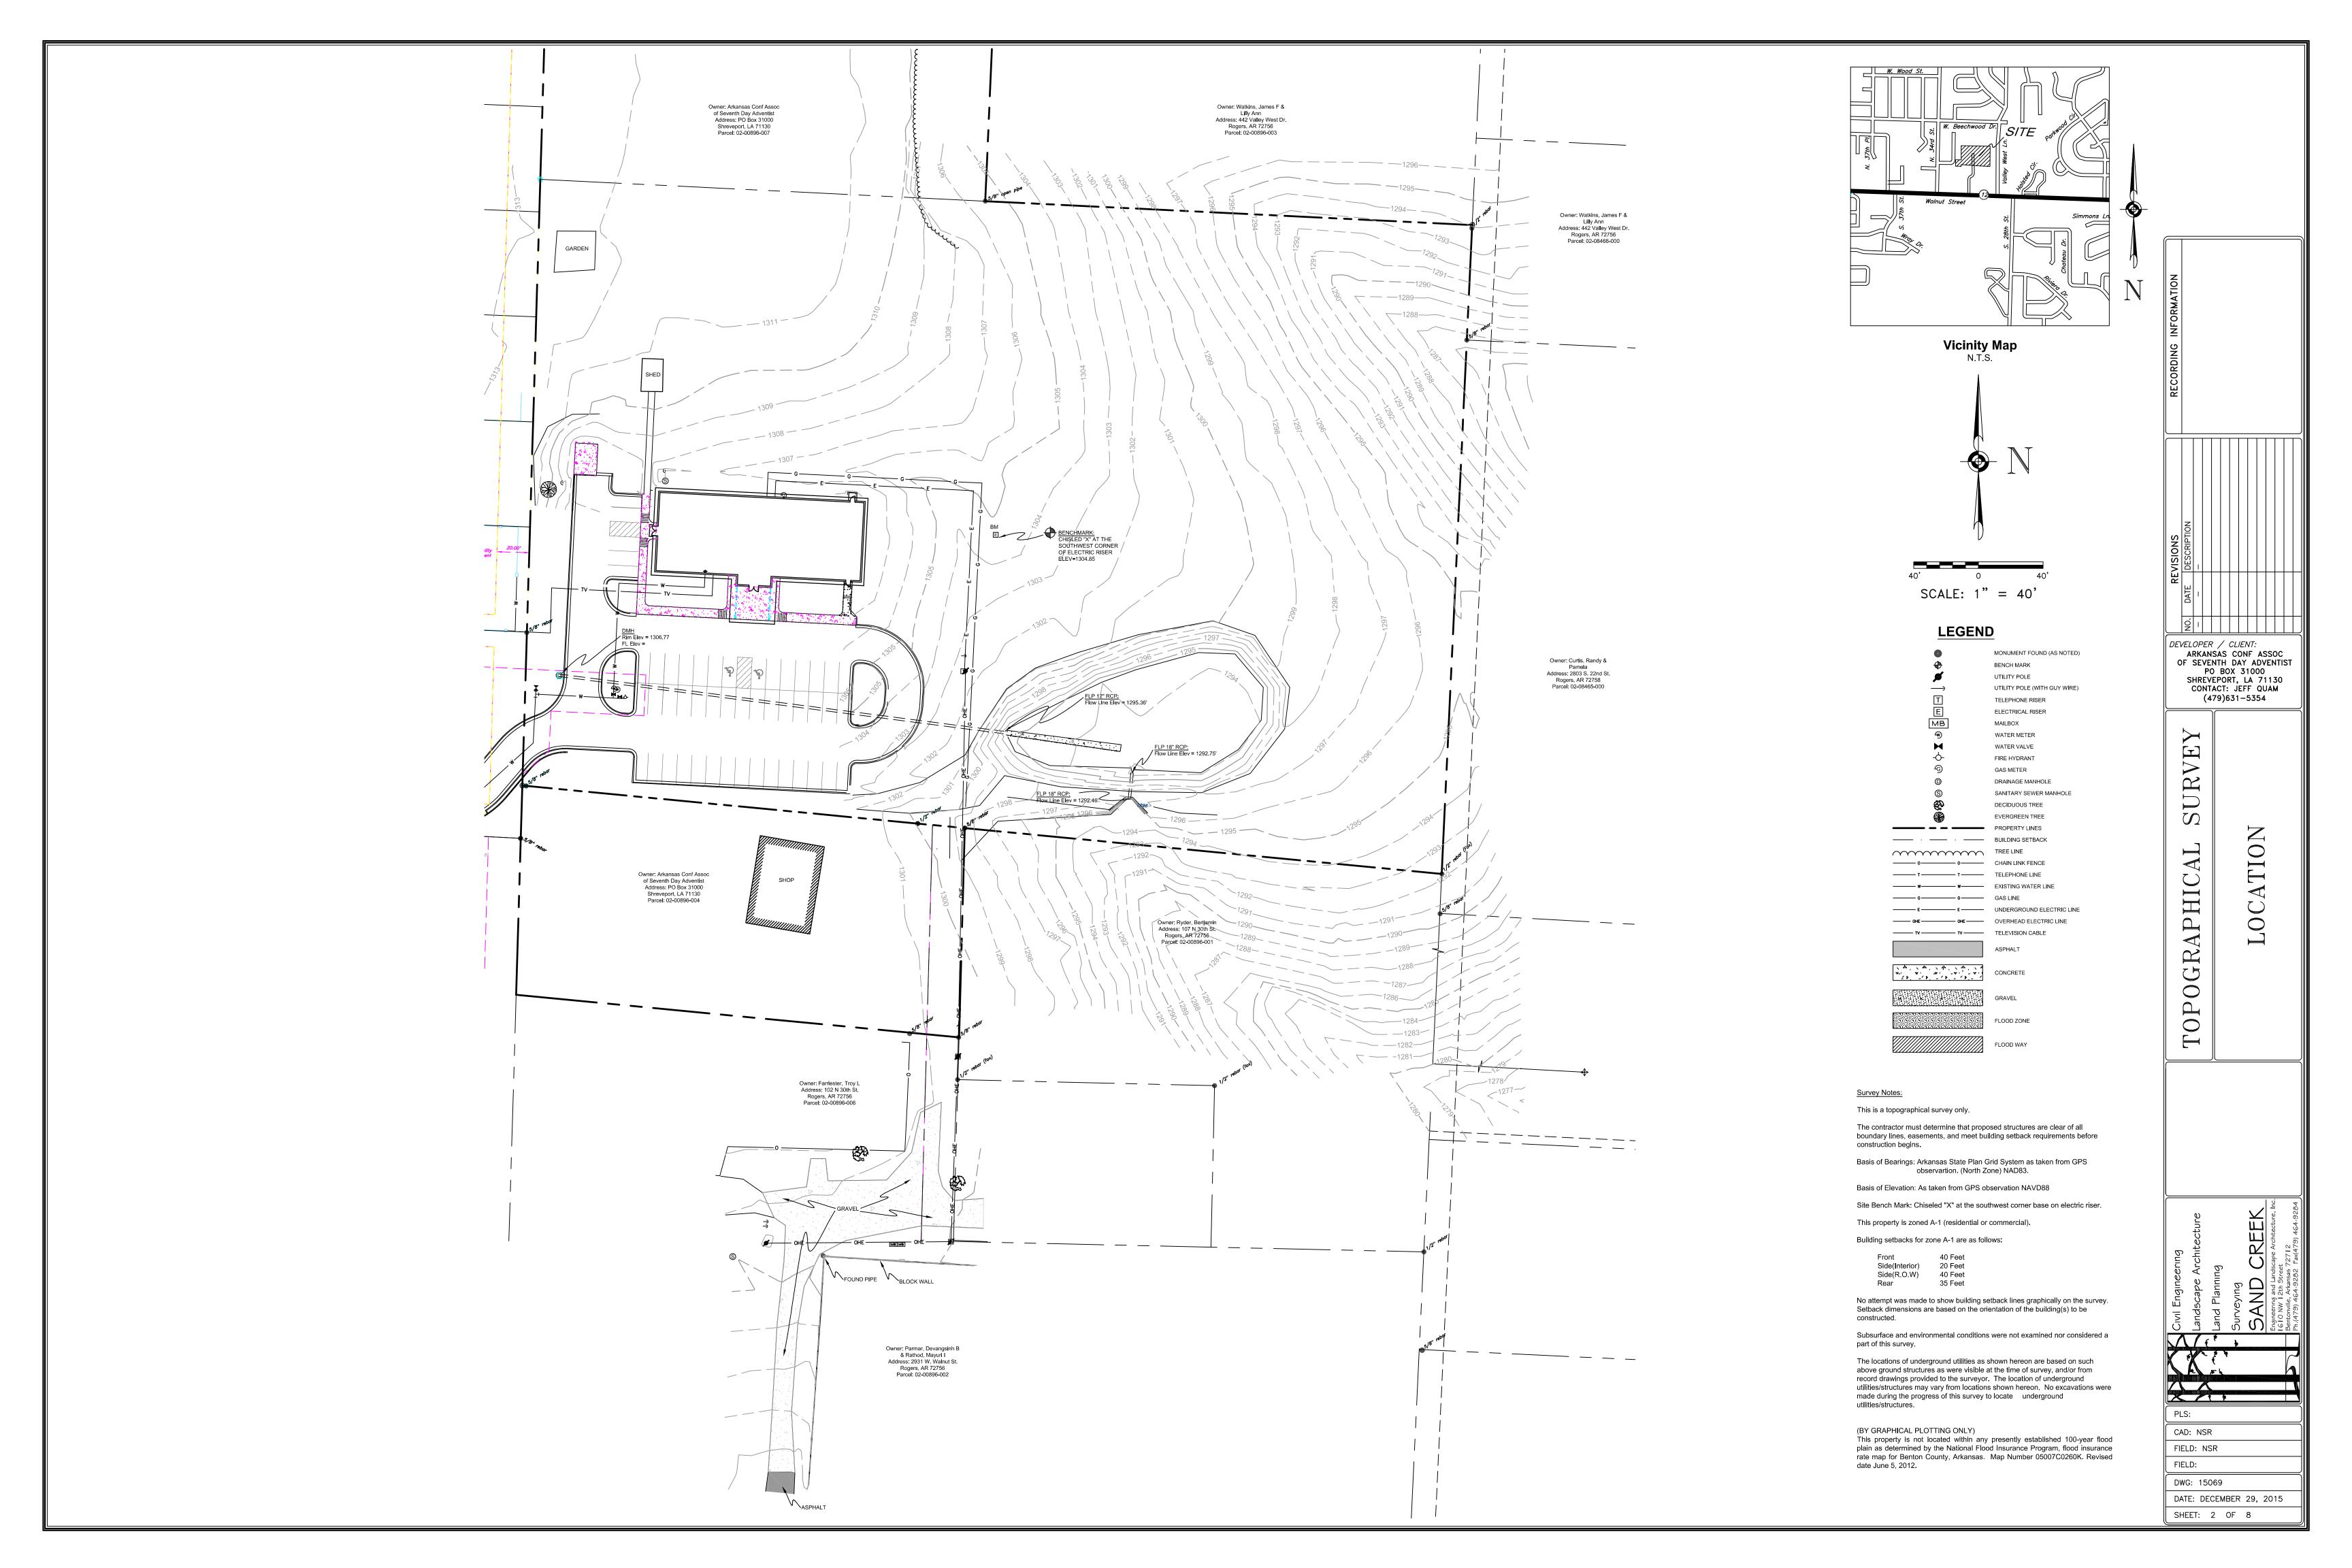

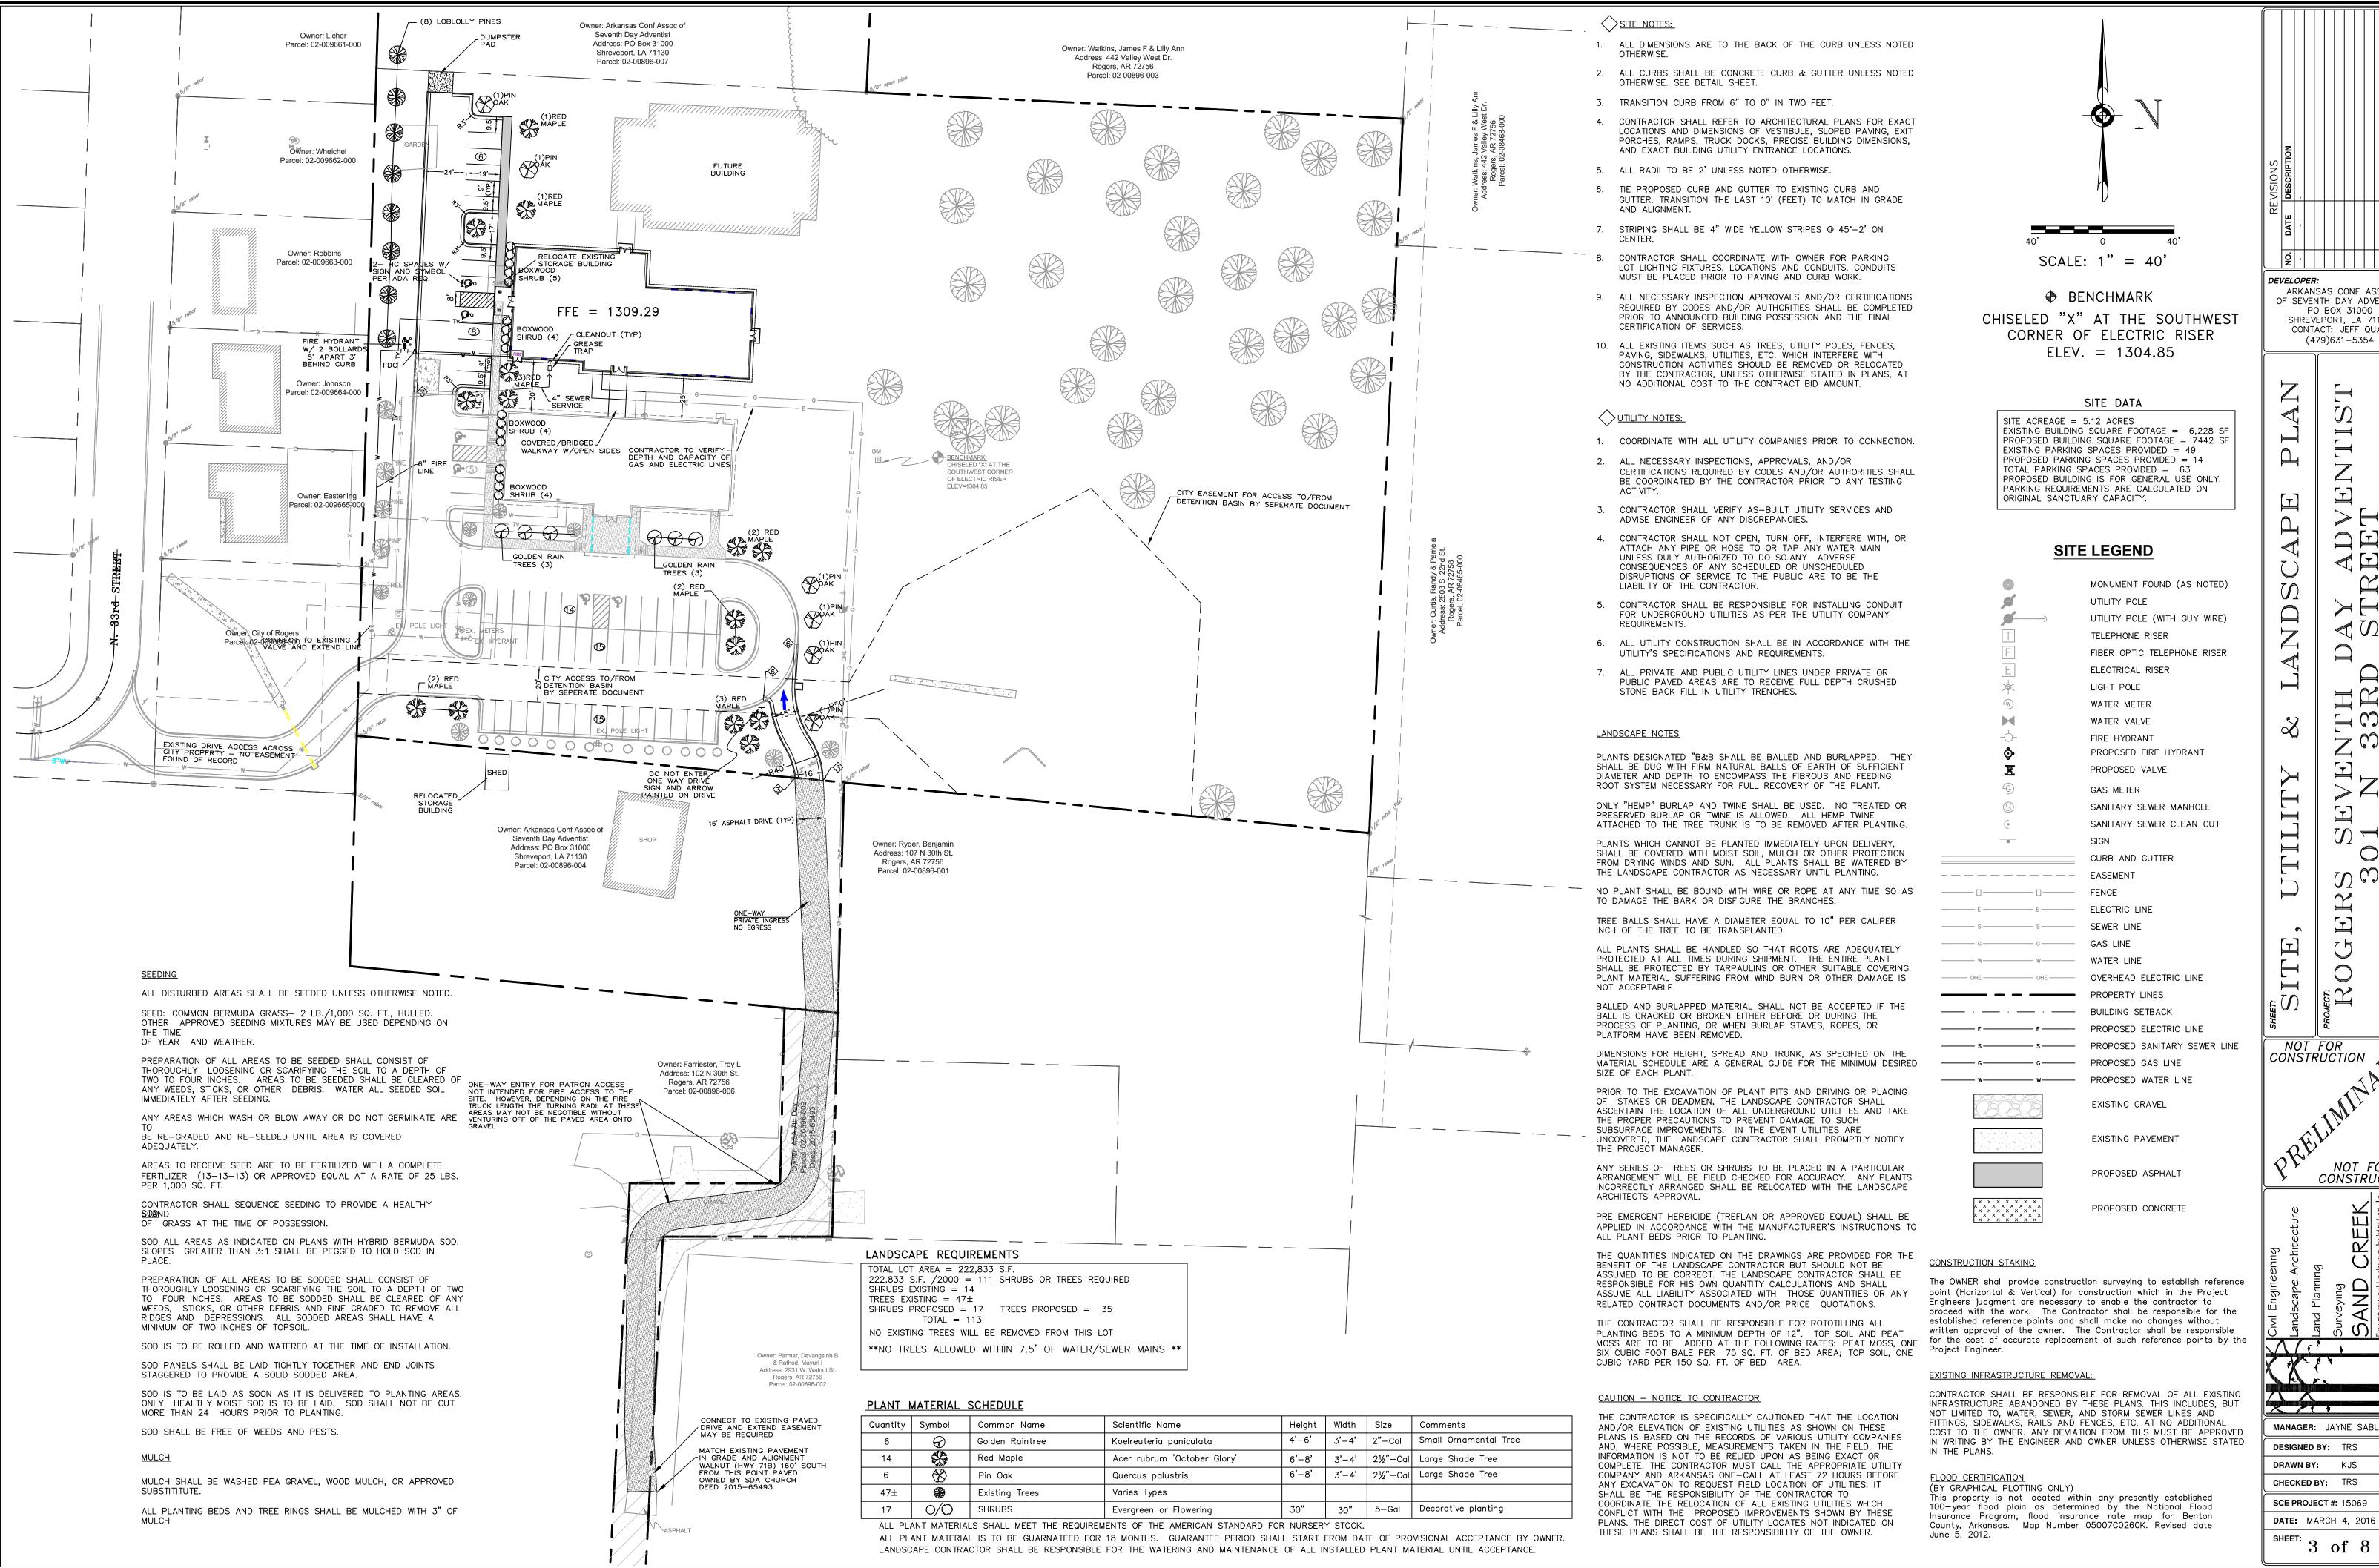



ARKANSAS CONF ASSOC OF SEVENTH DAY ADVENTIST PO BOX 31000 SHREVEPORT, LA 71130 CONTACT: JEFF QUAM (479)631-5354

CONSTRUCTIO

MANAGER: JAYNE SABLOTNE

**DATE:** MARCH 4, 2016

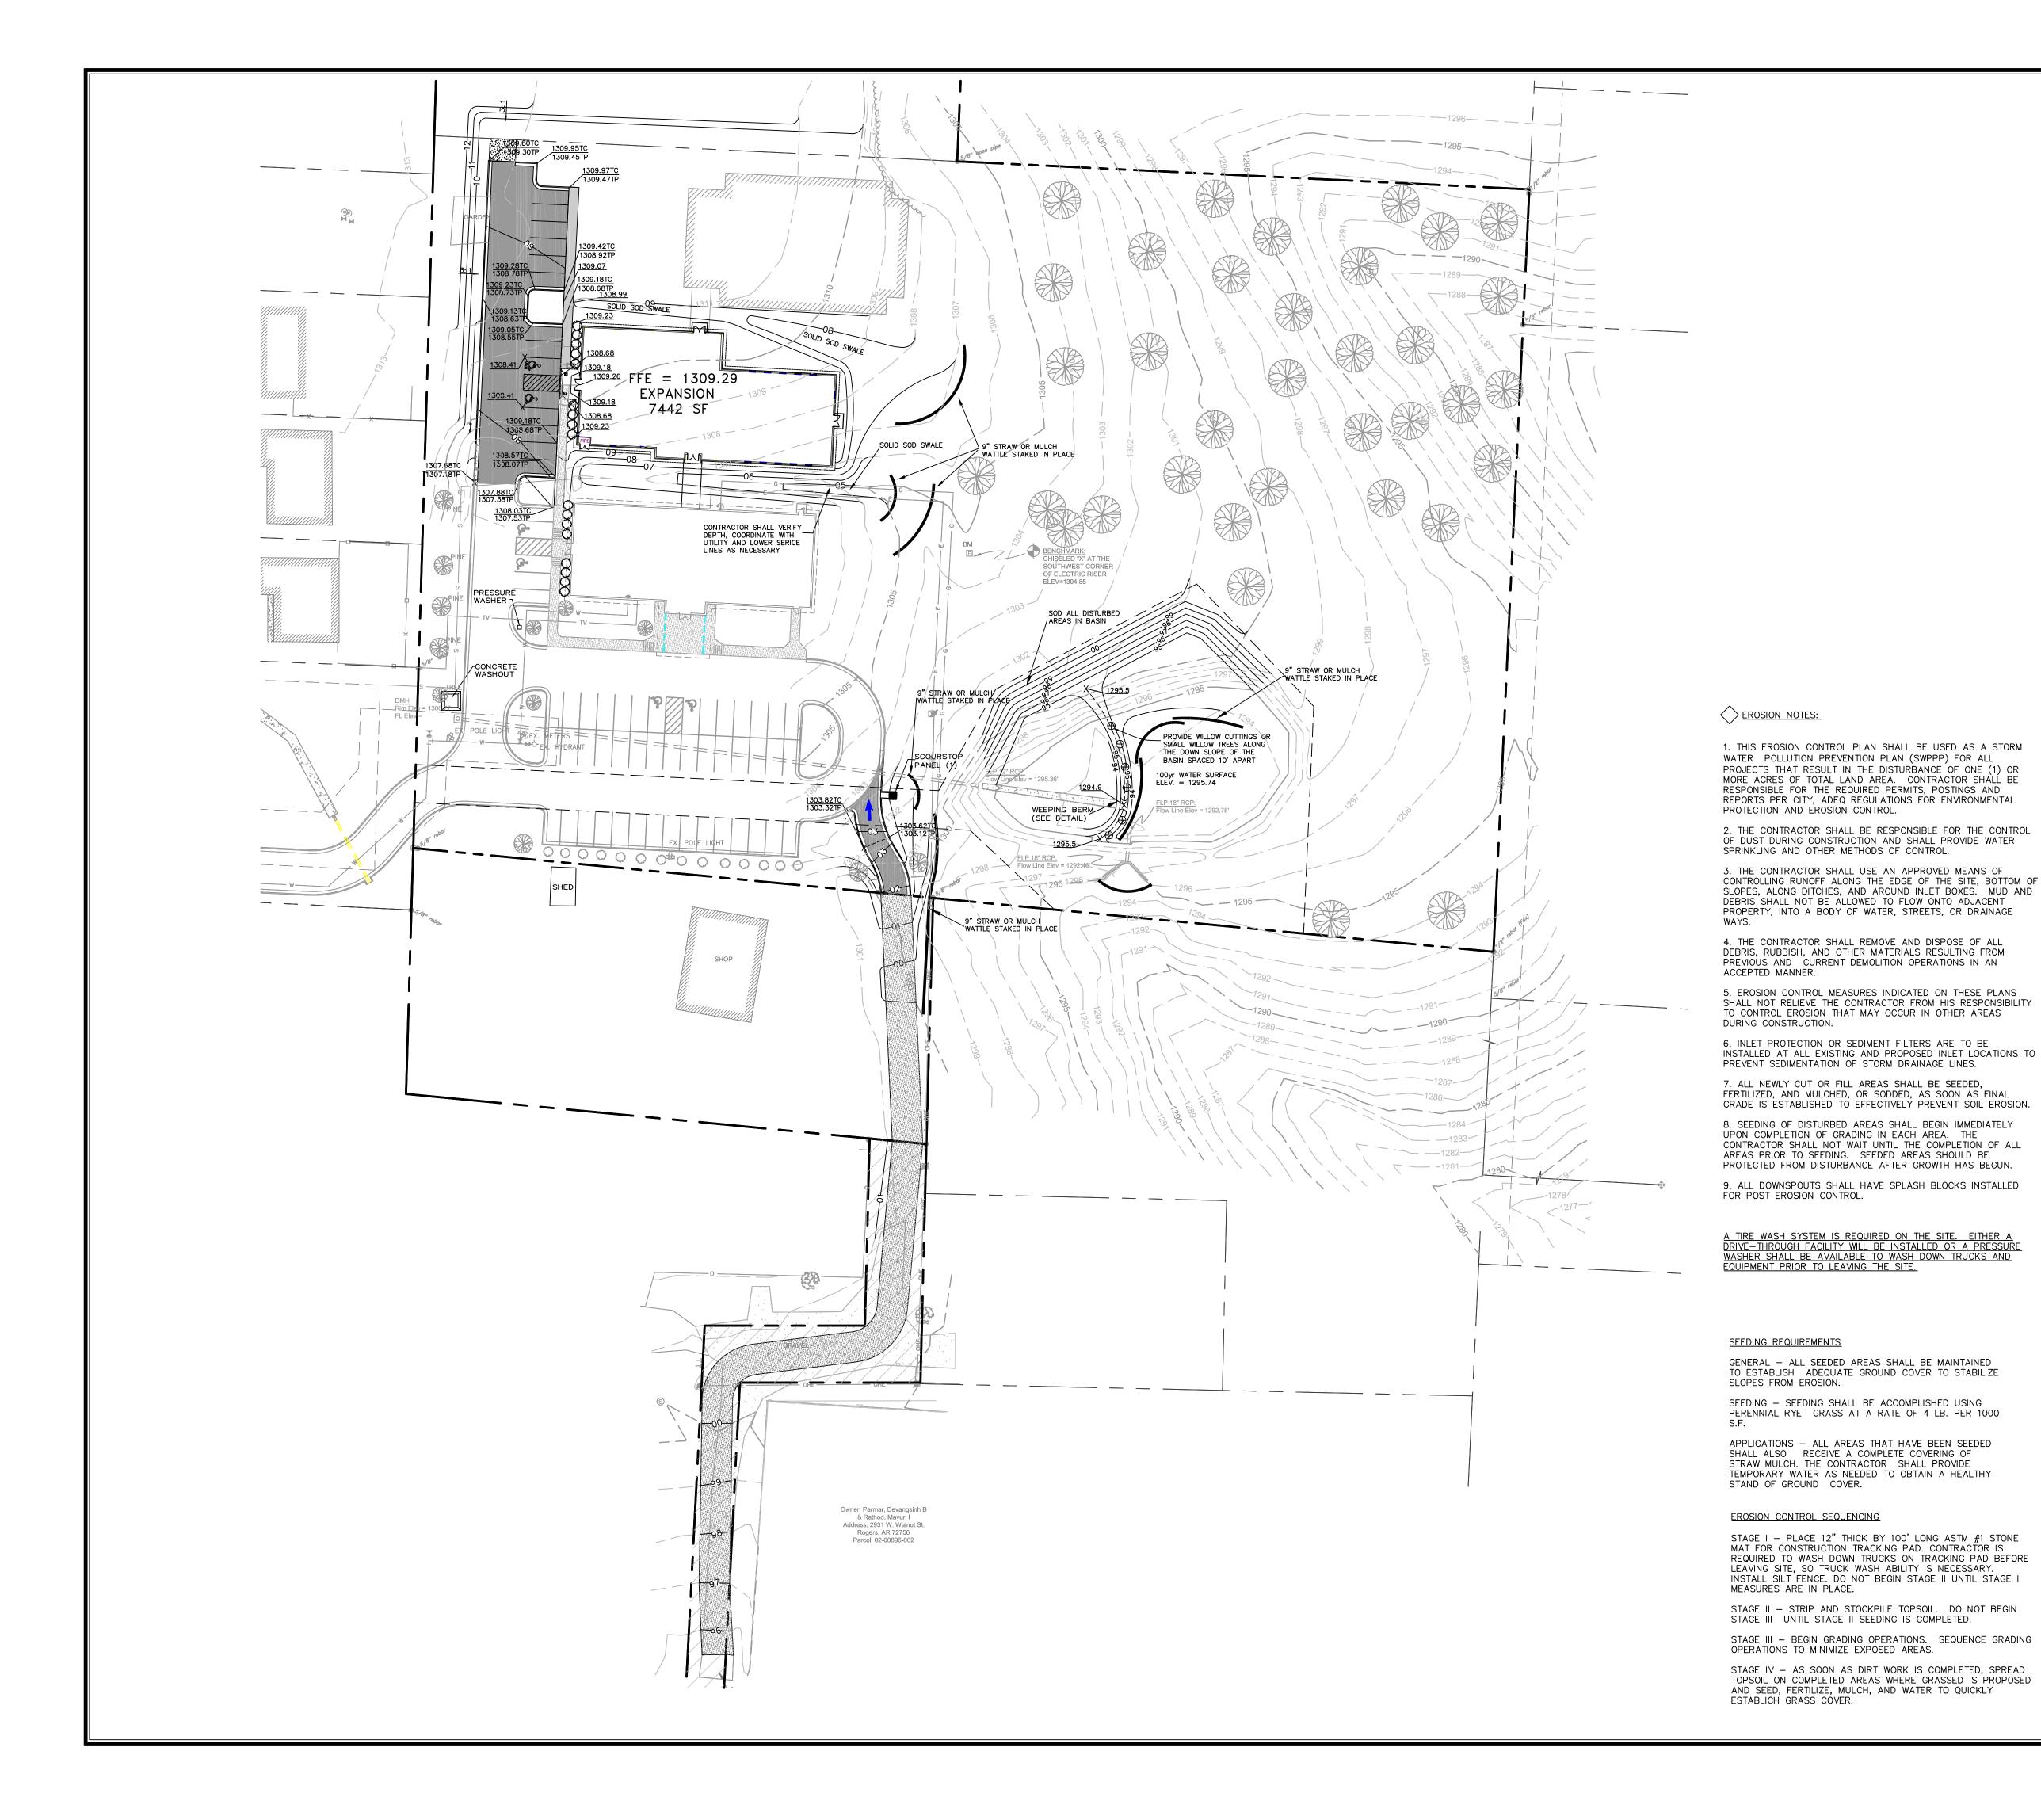

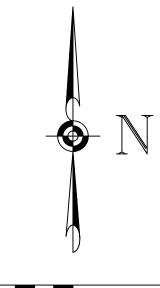

SCALE: 1" = 40'

#### BENCHMARK

CHISELED "X" AT THE SOUTHWEST CORNER OF ELECTRIC RISER ELEV. = 1304.85

#### GRADING LEGEND

- - PROPERTY LINE

– 6" CURB AND GUTTER

- SIDEWALK STANDARD DUTY CONCRETE - HEAVY DUTY CONCRETE

======== - EXISTING STORM SEWER



INLET PROTECTION

- SAND BAGS, OR MULCH WATTLE

FLOW DIRECTION ARROW

## SRADING NOTES:

- 1. COORDINATE WITH ALL UTILITIES PRIOR TO GRADING. 2. ALL DISTURBED AREAS SHALL RECEIVE TOPSOIL, SEED, AND MULCH OR SOD. WATER UNTIL A HEALTHY STAND OF GRASS IS
- OCCUPIED BY BUILDINGS AND PAVING. TOPSOIL FOR REPLACEMENT WITHIN TEN FEET OF THE EDGE OF THE BUILDING OR PAVED AREA. BURNING OF TIMBER AND DEBRIS WILL NOT BE PERMITTED UNLESS
- EIGHT-INCH DEPTH COMPACTED TO 95% STANDARD PROCTOR MAXIMUM DRY DENSITY. ANY UNSUITABLE AREAS SHALL BE UNDERCUT AND REPLACED WITH SUITABLE MATERIAL BEFORE ANY FILL MATERIAL CAN BE APPLIED.
- 5. OFF-SITE FILL MATERIAL SHALL HAVE A PLASTICITY INDEX BETWEEN 15 AND 45, A LIQUID LIMIT BETWEEN 40 AND 70, AND CONTAIN NO ROCK LARGER THAN FOUR INCHES. OTHER REQUIREMENTS AS
- 7. IN ALL AREAS OF EXCAVATION, IF UNSUITABLE SOIL CONDITIONS ARE ENCOUNTERED, A QUALIFIED GEOTECHNICAL ENGINEER SHALL RECOMMEND TO THE CONTRACTOR THE METHODS OF UNDERCUTTING AND REPLACEMENT OF PROPERLY COMPACTED, APPROVED FILL MATERIAL. ALL PROOF ROLLING AND UNDERCUTTING SHALL BE PERFORMED DURING A PERIOD OF DRY WEATHER.
- VERTICAL OR FLATTER UNLESS OTHERWISE INDICATED.
- SURFACE AREAS ON AND ADJACENT TO THE PROJECT SITE. IF PONDING POTENTIAL EXISTS THE CONTRACTOR SHALL NOTIFY THE ENGINEER TO INVESTIGATE SOLUTIONS.
- HOWEVER, THE CONTRACTOR SHALL NOT WORSEN ANY EXISTING CONDITION AS PART OF THIS PROJECT.

THE CONTRACTOR IS SPECIFICALLY CAUTIONED THAT THE LOCATION AND/OR ELEVATION OF EXISTING UTILITIES AS SHOWN ON THESE PLANS IS BASED ON THE RECORDS OF VARIOUS UTILITY COMPANIES AND, WHERE POSSIBLE, MEASUREMENTS TAKEN IN THE FIELD. THE INFORMATION IS NOT TO BE RELIED UPON AS BEING EXACT OR COMPLETE. THE CONTRACTOR MUST CALL THE APPROPRIATE UTILITY COMPANY AND ARKANSAS ONE-CALL AT LEAST 72 HOURS BEFORE ANY EXCAVATION TO REQUEST FIELD LOCATION OF UTILITIES. IT SHALL BE THE RESPONSIBILITY OF THE CONTRACTOR TO COORDINATE THE RELOCATION OF ALL EXISTING UTILITIES WHICH CONFLICT WITH THE PROPOSED IMPROVEMENTS SHOWN BY THESE PLANS. THE DIRECT COST OF UTILITY LOCATES NOT INDICATED ON THESE PLANS SHALL BE THE RESPONSIBILITY OF THE OWNER.

DEVELOPER: ARKANSAS CONF ASSOC OF SEVENTH DAY ADVENTIST PO BOX 31000 SHREVEPORT, LA 71130 CONTACT: JEFF QUAM

(479)631-5354

#### EROSION CONTROL LEGEND



SILT FENCE (OR EQUAL)

STONE TRACKING PAD

- 3. THE CONSTRUCTION AREA SHALL BE CLEARED, GRUBBED, AND STRIPPED OF TOPSOIL AND ORGANIC MATTER FROM ALL AREAS TO BE ON SLOPES MAY BE STOCKPILED ON SITE. EXCESS TOPSOIL MAY BE WASTED IN FILL SLOPES PROVIDED THAT NO TOPSOIL WILL BE WASTED APPROVAL IS OBTAINED FROM GOVERNING OFFICIALS.
- 4. AREAS TO RECEIVE FILL SHALL BE SCARIFIED AND THE TOP
- SPECIFIED IN GEOTECHNICAL REPORT SHALL BE FOLLOWED.
- AREAS TO BE CUT TO SUBGRADE LEVELS SHALL BE PROOF ROLLED WITH A FULLY LOADED TANDEM AXLE DUMP TRUCK OR SIMILAR APPROVED CONSTRUCTION EQUIPMENT TO DETECT UNSUITABLE SOIL CONDITIONS. AFTER CUTTING TO GRADE, CUT AREAS ARE TO BE RE-SCARIFIED AND RE-COMPACTED TO 95% STANDARD PROCTOR MAXIMUM DRY DENSITY AND TESTED BY A GEOTECHNICAL ENGINEER PRIOR TO PLACEMENT OF BASE MATERIAL.
- 8. ALL SLOPES ARE TO BE THREE-FOOT HORIZONTAL TO ONE FOOT
- 9. THE CONTRACTOR SHALL PROVIDE POSITIVE DRAINAGE ON ALL
- 10. ALL STORM SEWER CONNECTIONS TO EXISTING PIPES AND BOXES SHALL BE FINISH GROUTED TO PROVIDE A WATER TIGHT SEAL.
- 11. PRE-EXISTING DRAINAGE PROBLEMS BEYOND THE LIMITS OF RIGHT-OF-WAY MAY NOT BE RESOLVED BY PROPOSED IMPROVEMENTS,

#### <u>CAUTION - NOTICE TO CONTRACTOR</u>

CONSTRUCTION CONSTRUCTION

MANAGER: JAYNE SABLOTNE

**DESIGNED BY:** TRS DRAWN BY: KJS CHECKED BY: TRS

SCE PROJECT #: 15069 **DATE:** MARCH 4, 2016

4 of 8

